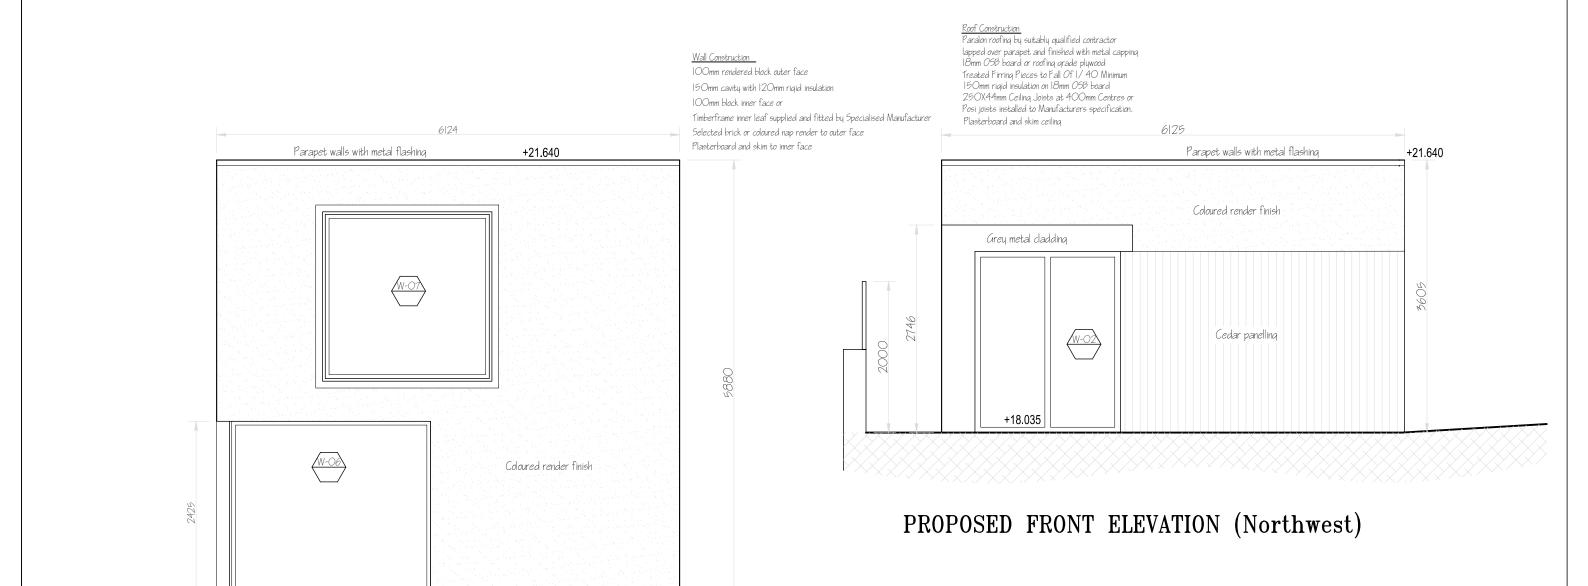
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All dimensions should be checked on site and the
Project Manager notified immediately of any discrepancies.
Drawings is to be read in conjunction with the specifications.
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PROPOSED REAR ELEVATION (Southeast)

+15.760

Notes:

All work to comply with Building Regulations 1997 or later.

It is the responsibility of the Building contractor to ensure all works comply with present Building Regulations

Do not scale drawings, use figured dimensions only.

All dimensions to be checked on site.

Where any discrepancy or error may occur, Architect to be notified prior to commencement of work.

Refer to Engineers drawings and specification for drainage layout. Connect all new drainage to existing nearest appropriate service

The contractor shall determine and quote for all required works to ensure all new works comply with the current Part L of the Buildiniq Regulations, note: this may require specification to be amended.

NOEL &	c VALERIE QUIRKE	AND ASSOCIATED SITE WO	D DWELLING HOUSE WITH ID PEDESTRIAN ACCESSES DRKS IN SIDE GARDEN OF BOUR ROAD, DALKEY.
FRONT & REAR ELEVATIONS		DESIGNED BY: GRANVILLE DESIGN SERVICE 55 GRANVILLE ROAD, DUN LAOGHAIRE, CO. DUBLIN. PHONE: 01-2840674 087-2345393 E-MAIL: granvilledesignservice@gmail.com	
DATE: AUGUST 2022	SCALE: 1:50	DRAWN BY: P.Mc Adam	DRAWING NO. 125/22/01

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Roof Construction
Paralon roofing by suitably qualified contractor
lapped over parapet and finished with metal capping 18mm 058 board or roofing grade plywood Treated Firring Pieces to Fall 0f 1/40 Minimum 150mm rigid insulation on 18mm 058 board 250X44mm Ceiling Joists at 400mm Centres or Posi joists installed to Manufacturers specification.

Wall Construction

100mm rendered block outer face


150mm cavity with 120mm rigid insulation

100mm block inner face or

Timberframe inner leaf supplied and fitted by Specialised Manufacturer

Selected brick or coloured nap render to outer face

Plasterboard and skim to inner face

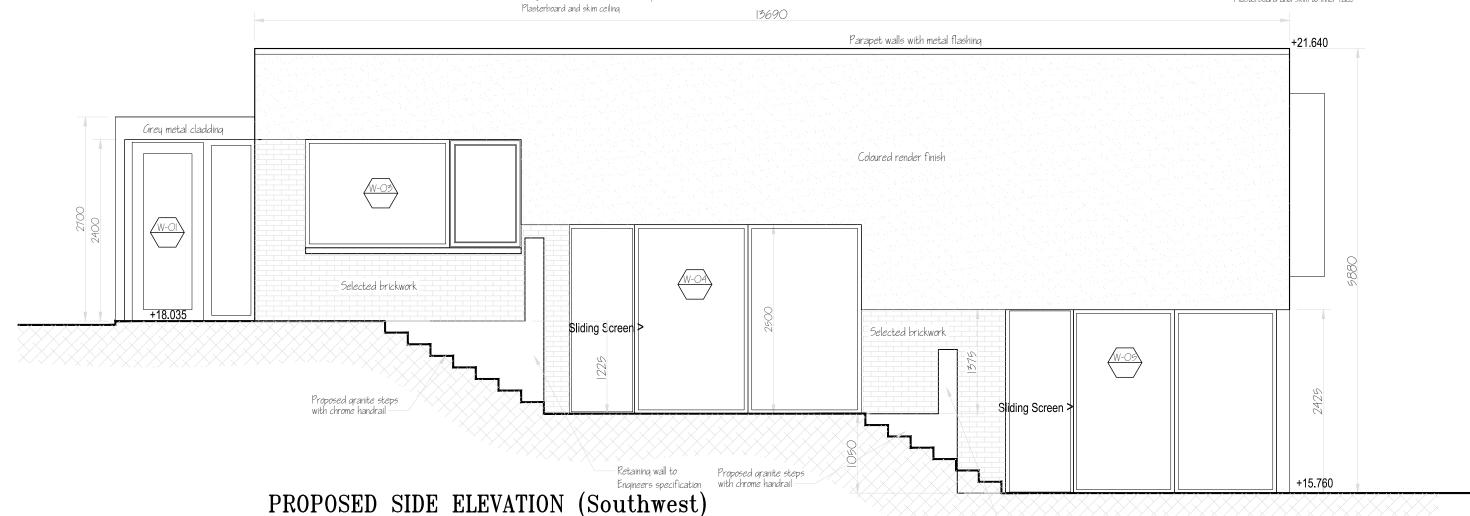

All work to comply with Building Regulations 1997 or later.

It is the responsibility of the Building contractor to ensure all works comply with present Building Regulations

Do not scale drawings, use figured dimensions only.

All dimensions to be checked on site.

Where any discrepancy or error may occur, Architect to be notified prior to commencement of work.

Refer to Engineers drawings and specification for drainage layout. Connect all new drainage to existing nearest appropriate service

The contractor shall determine and quote for all required works to ensure all new works comply with the current Part L of the Buildinia Regulations, note: this may require specification to be amended. Retaining wall to Engineers specification

CLIENT:	NOEL & VAL		JOB WILE:PROPOSED DETACHE WITH NEW VEHICULAR AN AND ASSOCIATED SITE WO 4 ROCKLANDS, HARE	ID PEDESTRIAN ACCESSES
SIDE ELEVATION				
DATE:	AUGUST 2022	SCALE: 1:50	DRAWN BY: P.Mc Adam	drawing no. 125/22/02

All dimensions should be checked on site and the Project Manager notified immediately of any discrepancies. Drawings is to be read in conjunction with the specifications. This Drawing is Copyright Roof Construction
Paralon roofing by suitably qualified contractor lapped over parapet and finished with metal capping 18mm OSB board or roofing grade plywood Treated Firring Pieces to Fall Of 1/40 Minimum 150mm rigid insulation on 18mm 05B board 250X44mm Ceiling Joists at 400mm Centres or Posi joists installed to Manufacturers specification. Plasterboard and skim ceiling 13690 1794 Parapet walls with metal flashing +21.640 Grey metal cladding Obscure glass triple glazed Aluclad window Coloured render finish scure glass triple 5880 +18.035 Selected brickwork Wall Construction 100mm rendered block outer face +16.810 150mm cavity with 120mm rigid insulation 100mm block inner face or Timberframe inner leaf supplied and fitted by Specialised Manufacturer Selected brick or coloured nap render to outer face Plasterboard and skim to inner face +15.760 PROPOSED SIDE ELEVATION (Northeast)

Notes:

All work to comply with Building Regulations 1997 or later.

It is the responsibility of the Building contractor to ensure all works comply with present Building Regulations

Do not scale drawings, use figured dimensions only.

All dimensions to be checked on site.


Where any discrepancy or error may occur, Architect to be notified prior to commencement of work.

Refer to Engineers drawings and specification for drainage layout. Connect all new drainage to existing nearest appropriate service

The contractor shall determine and quote for all required works to ensure all new works comply with the current Part L of the Buildiniq Regulations. note: this may require specification to be amended.


NOEL & VALERIE QUIRKE NOEL & VALERIE & VALERIE QUIRKE NOEL & VALERIE QUIRKE NOEL & VALERIE & VALER

Do not scale drawing, use figured dimensions only.

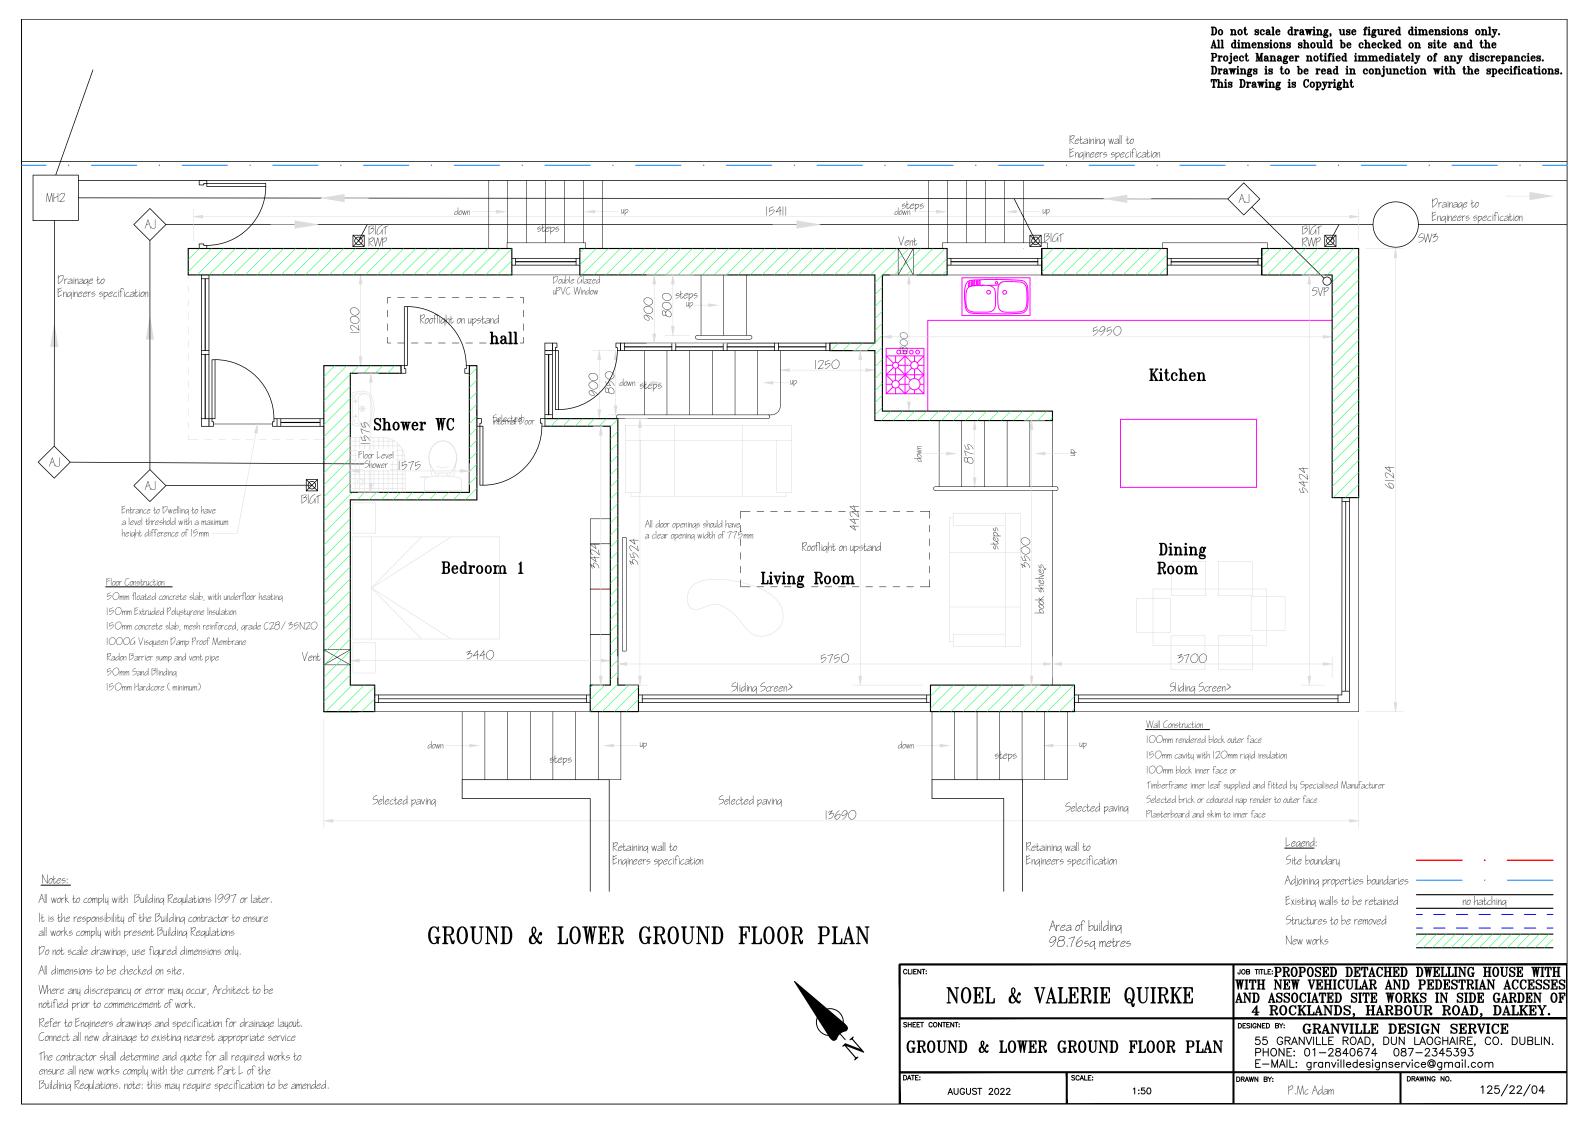

Do not scale drawing, use figured dimensions only. All dimensions should be checked on site and the Project Manager notified immediately of any discrepancies. Drawings is to be read in conjunction with the specifications. This Drawing is Copyright

Retaining wall to Engineers specification

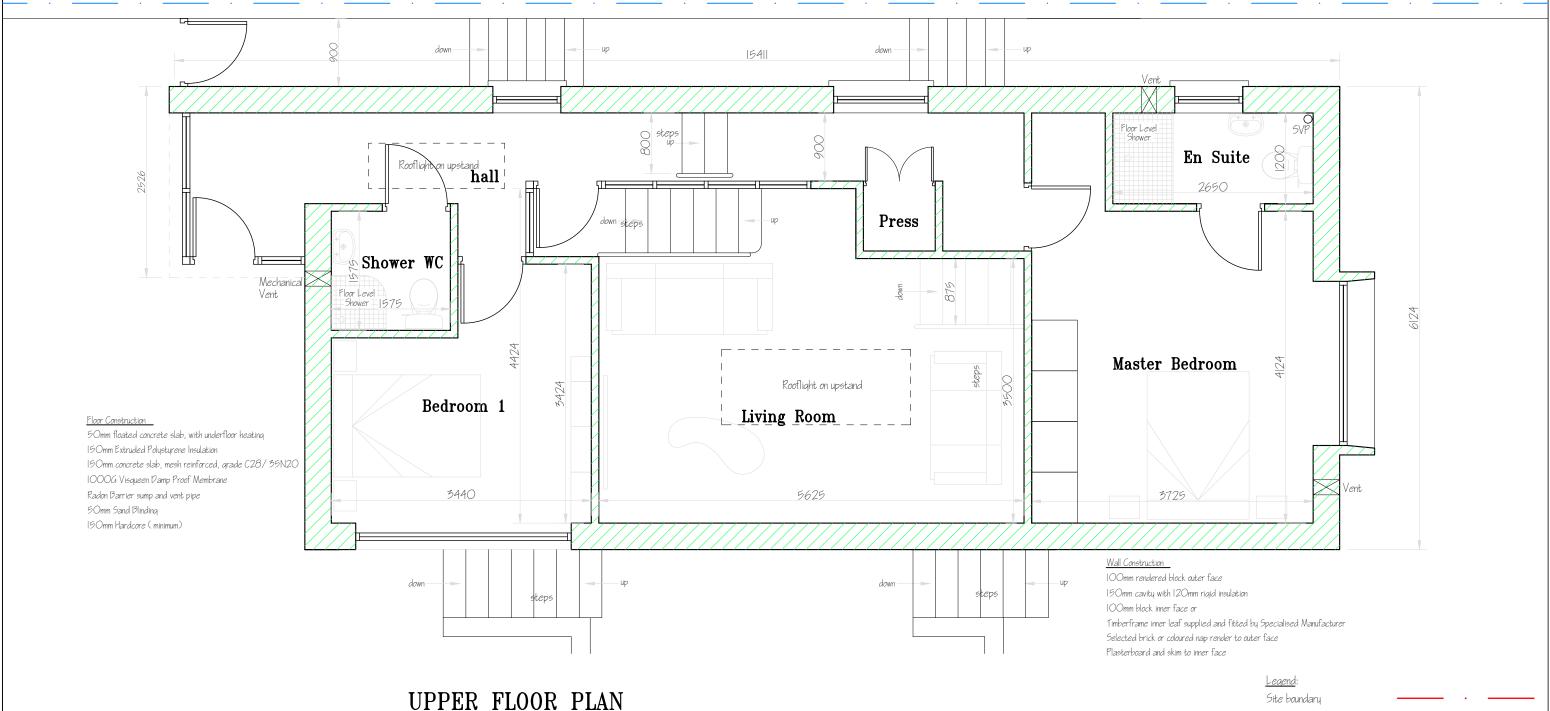

All work to comply with Building Regulations 1997 or later.

It is the responsibility of the Building contractor to ensure all works comply with present Building Regulations

Do not scale drawings, use figured dimensions only.

All dimensions to be checked on site.

Where any discrepancy or error may occur, Architect to be notified prior to commencement of work.

Refer to Engineers drawings and specification for drainage layout. Connect all new drainage to existing nearest appropriate service

The contractor shall determine and quote for all required works to ensure all new works comply with the current Part L of the Buildinia Regulations. note: this may require specification to be amended.

Area of building 98.76sa metres

Adjoining properties boundaries Existing walls to be retained no hatching Structures to be removed New works



NOEL & VALERIE QUIRKE

SHEET CONTENT:

UPPER FLOOR PLAN

JOB TITLE:PROPOSED DETACHED DWELLING HOUSE WITH WITH NEW VEHICULAR AND PEDESTRIAN ACCESSES AND ASSOCIATED SITE WORKS IN SIDE GARDEN OF 4 ROCKLANDS, HARBOUR ROAD, DALKEY.

GRANVILLE DESIGN SERVICE
55 GRANVILLE ROAD, DUN LAOGHAIRE, CO. DUBLIN.
PHONE: 01-2840674 087-2345393

125/22/05

E-MAIL: granvilledesignservice@gmail.com

AUGUST 2022 1:50 P.Mc Adam

Do not scale drawing, use figured dimensions only. All dimensions should be checked on site and the Project Manager notified immediately of any discrepancies. Drawings is to be read in conjunction with the specifications. This Drawing is Copyright Parapet walls with metal flashing Rooflight on upstand Solar Panels by Specialist Contractors Location to be agreed on site 1794 Flat Roof Fall Rooflight on upstand location to be agreed on site Paralon roofing by suitably qualified contractor lapped over parapet and finished with metal capping 18mm 053 board or roofing grade plywood Treated Firring Pieces to Fall 0f 1/40 Minimum 150mm riqid insulation on 18mm 0513 board 250X44mm Ceiling Joists at 400mm Centres or Posi joists installed to Manufacturers specification. Plasterboard and skim ceiling Parapet walls with metal flashing down 13690 Legend: ROOF PLAN Site boundary Adjoining properties boundaries All work to comply with Building Regulations 1997 or later. Existing walls to be retained no hatching It is the responsibility of the Building contractor to ensure Structures to be removed all works comply with present Building Regulations New works Do not scale drawings, use figured dimensions only. JOB TITLE: PROPOSED DETACHED DWELLING HOUSE WITH WITH NEW VEHICULAR AND PEDESTRIAN ACCESSES AND ASSOCIATED SITE WORKS IN SIDE GARDEN OF 4 ROCKLANDS, HARBOUR ROAD, DALKEY. All dimensions to be checked on site. Where any discrepancy or error may occur, Architect to be NOEL & VALERIE QUIRKE notified prior to commencement of work. Refer to Engineers drawings and specification for drainage layout. SHEET CONTENT: GRANVILLE DESIGN SERVICE
55 GRANVILLE ROAD, DUN LAOGHAIRE, CO. DUBLIN.
PHONE: 01-2840674 087-2345393 Connect all new drainage to existing nearest appropriate service ROOF PLAN The contractor shall determine and quote for all required works to E-MAIL: granvilledesignservice@gmail.com ensure all new works comply with the current Part L of the Buildinia Regulations. note: this may require specification to be amended. AUGUST 2022 1:50 P.Mc Adam 125/22/06

Do not scale drawing, use figured dimensions only. All dimensions should be checked on site and the Project Manager notified immediately of any discrepancies. Drawings is to be read in conjunction with the specifications. This Drawing is Copyright Roof Construction Wall Construction_ Paralon roofing by suitably qualified contractor 100mm rendered block outer face lapped over parapet and finished with metal capping 150mm cavity with 120mm rigid insulation 18mm OSB board or roofing grade plywood 100mm block inner face or Treated Firring Pieces to Fall Of 1/40 Minimum 150mm rigid insulation on 18mm 05B board Employ a Consultant Engineer to provide details Timberframe inner leaf supplied and fitted by Specialised Manufacturer 250X44mm Ceiling Joists at 400mm Centres or Selected brick or coloured nap render to outer face Posi joists installed to Manufacturers specification. Plasterboard and skim to inner face Plasterboard and skim ceiling Parapet wall with metal capping Precast concrete lintol Grey metal cladding 100x50mm S.W. studs at 400mm Centres Acoustic plasterboard both sides Triple glazed white Aluclad window Bedroom 2 Bedroom 1 Cedar panelling Posi strut floor joists to size Living Room recommended by Manufacturer Plasterboard and skim ceiling Triple glazed white Aluclad sliding doors Dining Room Retaining wall and footings to Structural Engineers specification 50mm floated concrete slab, with underfloor heating 150mm Extruded Polystyrene Insulation 150mm concrete slab, mesh reinforced, grade C28/35N20 1000G Visqueen Damp Proof Membrane Rising Walls to DPC Level to be Solid Concrete Blockwork bedded Radon Barrier sump and vent pipe PROPOSED SECTION in Sand/Cement Mortar 50mm Sand Blindina 150mm Hardcore (minimum) Retaining wall and footings to Structural Engineers specification Excavate Foundation Trenches All work to comply with Building Regulations 1997 or later. Wall construction Porch roofing and walls to min. 450mm below Ground Level It is the responsibility of the Building contractor to ensure 100mm rendered blockwork outer face, 150mm cavity with 120mm rigid insulation. Selected Zinc metal roofing Rheinzinc or similar, laid and Provide Concrete Foundations all works comply with present Building Regulations 100mm blockwork inner face with plasterboard and skim finish. in accordance with in accordance with Manufacturers instructions. Laid on 18mm external OSB board on treated timber joists Do not scale drawings, use figured dimensions only. The Works should be Inspected at various stages of construction and Clau brick masonru units shall be in accordance with 1.5, EN 771 at completion and certified as complying with the Building Regulations All dimensions to be checked on site. All workmanship and materials used shall comply with Cedar panelling to be fixed on battens to blockwork and agreed with Client Where any discrepancy or error may occur, Architect to be Part D of the First Schedule to the Building Regulations notified prior to commencement of work. The main contractor shall be responsible for the co-ordination of all All walls to be removed on the site are blockwork or concrete the various sub-contractors work, and for their proper progress in the Refer to Engineers drawings and specification for drainage layout. appropriate order to ensure completion of the project. Structural steel to be fabricated in accordance with I.S. EN 1993-2005 Connect all new drainage to existing nearest appropriate service All new timber stud walls to be acquestically insulated, slabbed and The contractor shall determine and auote for all required works to skimmed with plaster finish. Moisture resistant boards to be provided ensure all new works comply with the current Part L of the Buildiniq Regulations. note: this may require specification to be amended. in rooms, (Bathroom, En-Suite and Kitchen JOB TITLE: PROPOSED DETACHED DWELLING HOUSE WITH Blockwork below DPC to be 450x225x100mm approved All steelwork to be marked by a CE approved Fabricator WITH NEW VEHICULAR AND PEDESTRIAN ACCESSES AND ASSOCIATED SITE WORKS IN SIDE GARDEN OF NOEL & VALERIE QUIRKE Use 10mm thick gusset, fin & end plates all round. All welds to be 6mm Strip Foundations in concrete (1:5) to size and depth shown. continuous fillets full profile. All bolts to be 20mm 4 ROCKLANDS, HARBOUR ROAD, DALKEY. SHEET CONTENT: Where drains pass under buildings, pipes are to be encased solid blocks, bedded in cement mortar (3:1) GRANVILLE DESIGN SERVICE 55 GRANVILLE ROAD, DUN LAOGHAIRE, CO. DUBLIN. PHONE: 01–2840674 087–2345393 in concrete min. 100min thick. SECTION THRU BUILDING Excavation to be min, 600mm below G.L. Where drains pass under walls a precast concrete lintol is to be E-MAIL: granvilledesignservice@gmail.com Reinforcing bars shall be high yield Type 2 deformed bars to BS.4449 placed in wall over drain to prevent damage to drain.

1:50

AUGUST 2022

P.Mc Adam

125/22/07

Reinforcing mesh shall be high yield reinforcing fabric to BS.4483


All new sanitary pipework shall conform to BS.5572:1978, Provide cleaning access to all bends

Do not scale drawing, use figured dimensions only.


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ELEVATION OF VEHICULAR ACCESS




PLAN OF VEHICULAR ACCESS

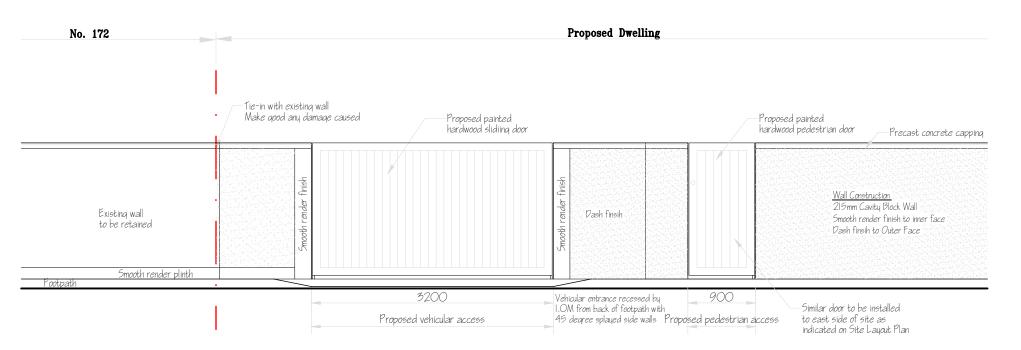
NOEL & VALERIE QUIRKE	JOB TITLE: PROPOSED DETACHED DWELLING HOUSE WITH WITH NEW VEHICULAR AND PEDESTRIAN ACCESSES AND ASSOCIATED SITE WORKS IN SIDE GARDEN OF 4 ROCKLANDS, HARBOUR ROAD, DALKEY.	
ELEVATION AND PLAN OF ENTRANCE State		
DATE: SCALE: 1:50	DRAWN BY: DRAWING NO. 125/22/09	


Do not scale drawing, use figured dimensions only.

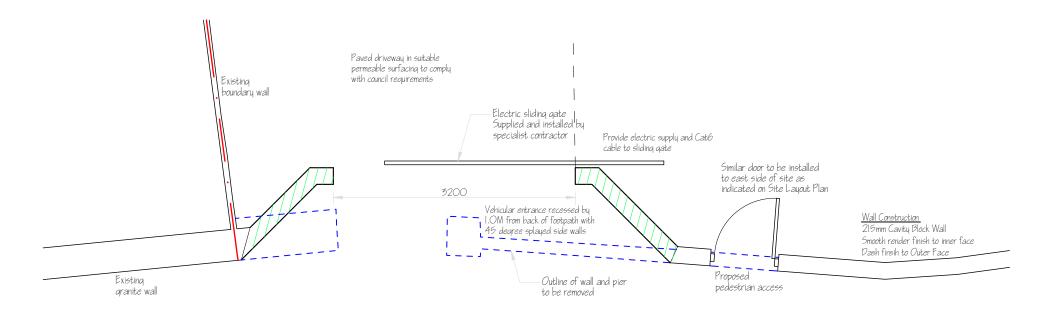
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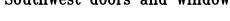




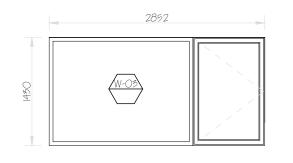

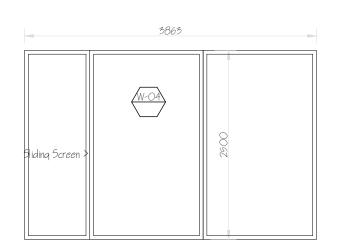


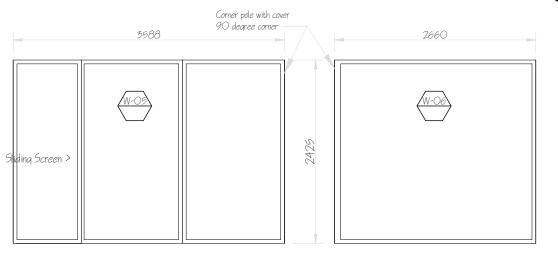
Southwest doors and window

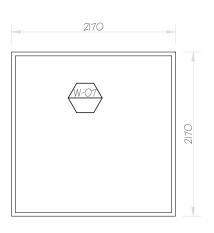

900 1250 900 1250 1250

Northeast glazed panel and windows

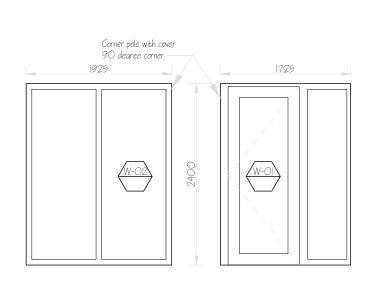

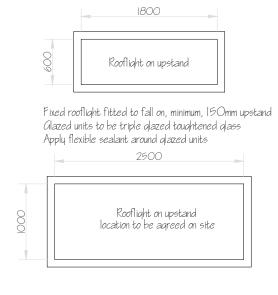

Front door and side panels

Southeast glazed panel and window

External windows and screens to be triple glazed Aluclad

With Argon gas filled 12mm gap with opening casements with stay arms.

Window colour 113C and configuration to be confirmed with Architect and Client prior to commissioning

Apply flexible sealant around windows frames internally and externally to limit air infiltration in accordance with Part L of the current Building Regulations.

Air tightness tape to be supplied and fitted at all window/door junctions

Air tightness tests must be undertaken by Specialists

Architect to be notified of supplier in advance of order being placed


All doors, windows and screens should be fitted by the supplier

Window cills, window boards and mastic supplied and fitted by the contractor

Supply and fit toughened glass triple galzed rooflight on 150mm roof upstand as indicated on the drawings and in accordance with manufacturers instructions. Include for flashing and finishing around opening in a neat and tidy manner.

NOEL & VALERIE QUIRKE	JOB TITLE: PROPOSED DETACHED DWELLING HOUSE WITH WITH NEW VEHICULAR AND PEDESTRIAN ACCESSES AND ASSOCIATED SITE WORKS IN SIDE GARDEN OF 4 ROCKLANDS, HARBOUR ROAD, DALKEY.
DOOR AND WINDOW SCHEDULE	DESIGNED BY: GRANVILLE DESIGN SERVICE 55 GRANVILLE ROAD, DUN LAOGHAIRE, CO. DUBLIN. PHONE: 01-2840674 087-2345393 E-MAIL: granvilledesignservice@gmail.com
DATE: SCALE: 1:50	DRAWING NO. 125/22/10

Retaining wall to

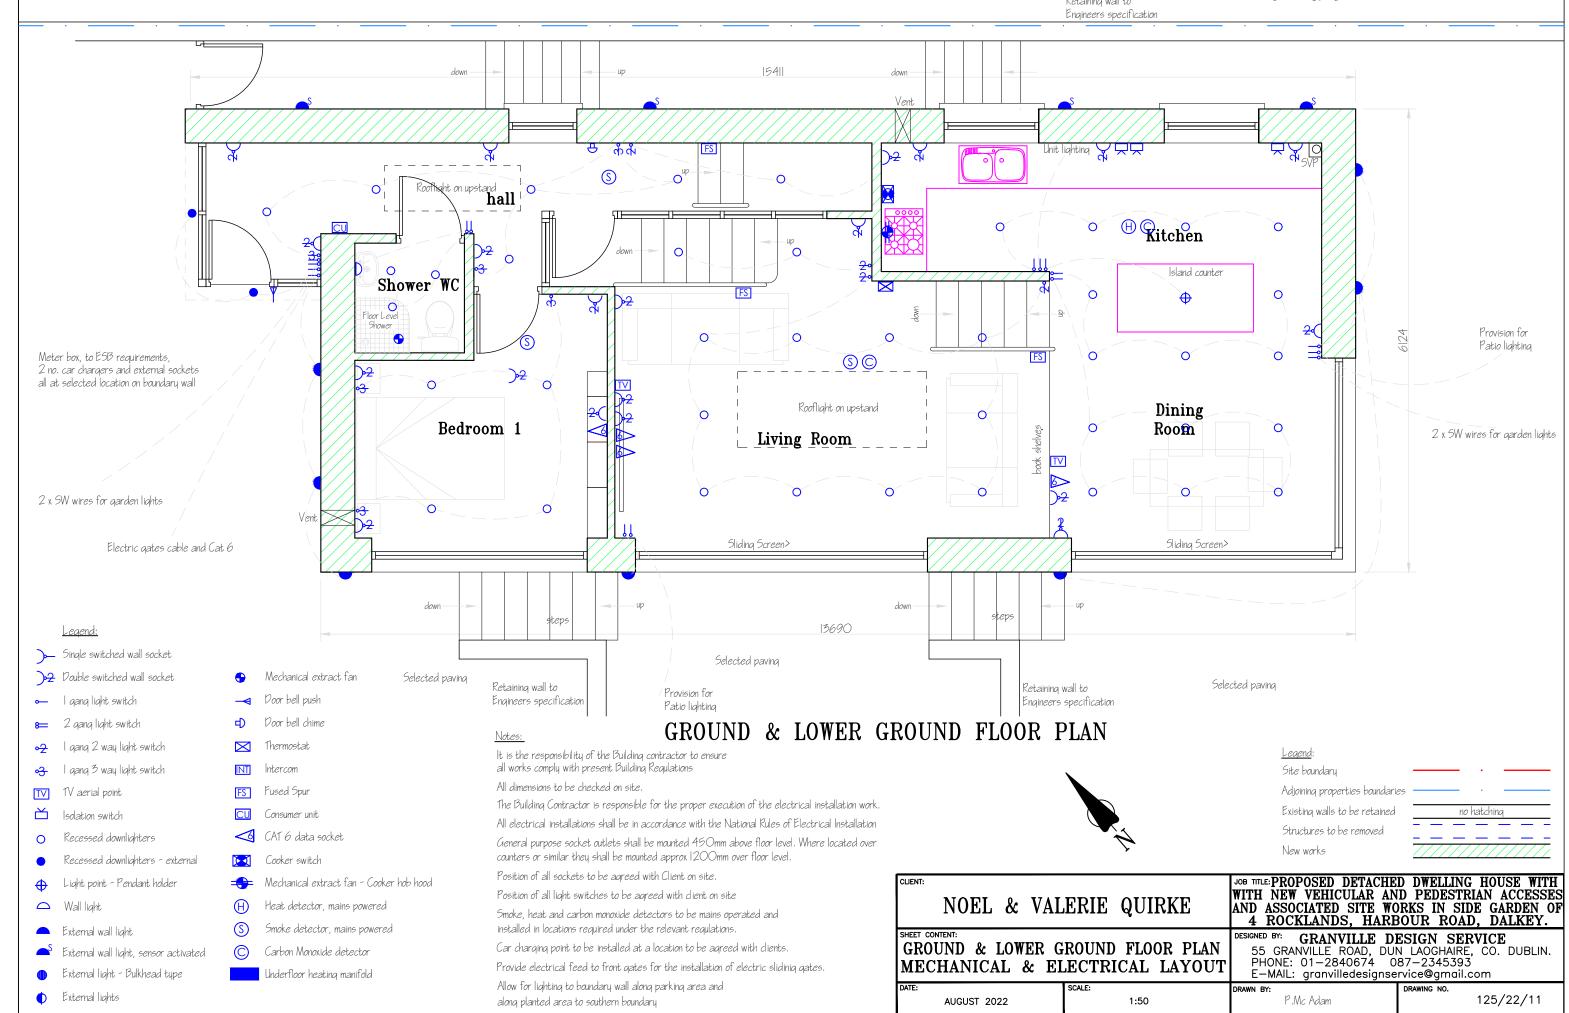

Retaining wall to

